



GENERAL NOTES


1. THESE DRAWINGS SHALL NOT BE SCALED.
2. THE CONTRACTOR SHALL VISIT THE SITE AND SATISFY ONESELF ALL DIMENSIONS, DATUM AND DETAILED INFORMATION SHOWN ARE CORRECT.
3. THE CONTRACTOR IS TO REVIEW AND COORDINATE ALL ARCHITECTURAL, MECHANICAL, ELECTRICAL AND STRUCTURAL DRAWINGS FOR ADDITIONAL OPENINGS THROUGH FLOORS, WALLS, AND CEILINGS FOR DUCT, PIPE & ELECTRICAL RISERS AND ALL OPENINGS NOT SHOWN ON DRAWINGS.
4. ALL OPENINGS THROUGH FIRE ASSEMBLIES ARE TO BE FIRE STOPPED AND SEALED WITH ULC APPROVED FIRE STOPPING TO MAINTAIN THE INTEGRITY OF THE FIRE SEPARATION, AND PROVIDE A SMOKE-TIGHT BARRIER.
5. ALL PRODUCTS AND MATERIALS TO BE USED AND INSTALLED SHALL CONFORM WITH MANUFACTURER'S SPECIFICATIONS & APPLICABLE CODES.
6. THE CONTRACTOR SHALL BE RESPONSIBLE TO PATCH AND MAKE GOOD ALL EXISTING CONSTRUCTION AFFECTED BY THE REMOVAL OF ALL ITEMS FORMING THE PART OF THE RENOVATION WORK.
7. WHERE NEW FLOORING AND BASE IS TO BE INSTALLED IN EXISTING AREAS (REFER TO FLOOR PLAN AND ROOM SCHEDULE) THE EXISTING FLOORING SURFACE AND BASE MUST BE REMOVED, UNLESS OTHERWISE NOTED. ALL FLOOR SURFACES SHALL BE PREPARED IN ACCORDANCE TO MANUFACTURER'S RECOMMENDATIONS FOR INSTALLATION OF NEW FLOOR.
7. WHERE PAINTING OF EXISTING WALLS IS INDICATED ON THE ROOM SCHEDULE, THESE WALLS MUST BE CLEANED OF ANY EXISTING WALL COVERING, PATCHED & PREPARED TO ACCEPT NEW MATERIAL, UNLESS OTHERWISE NOTED.

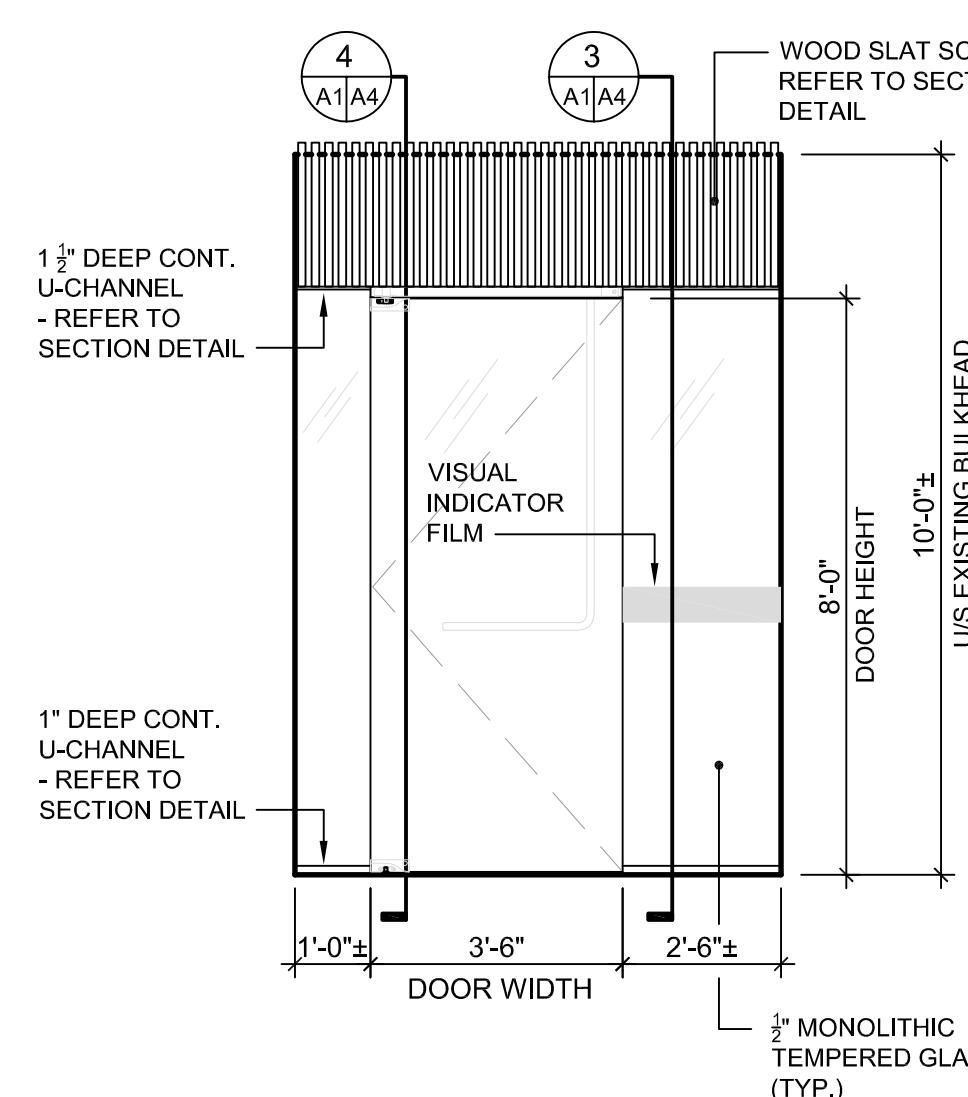

ELEVATION
SCALE: 3/8" = 1'-0"

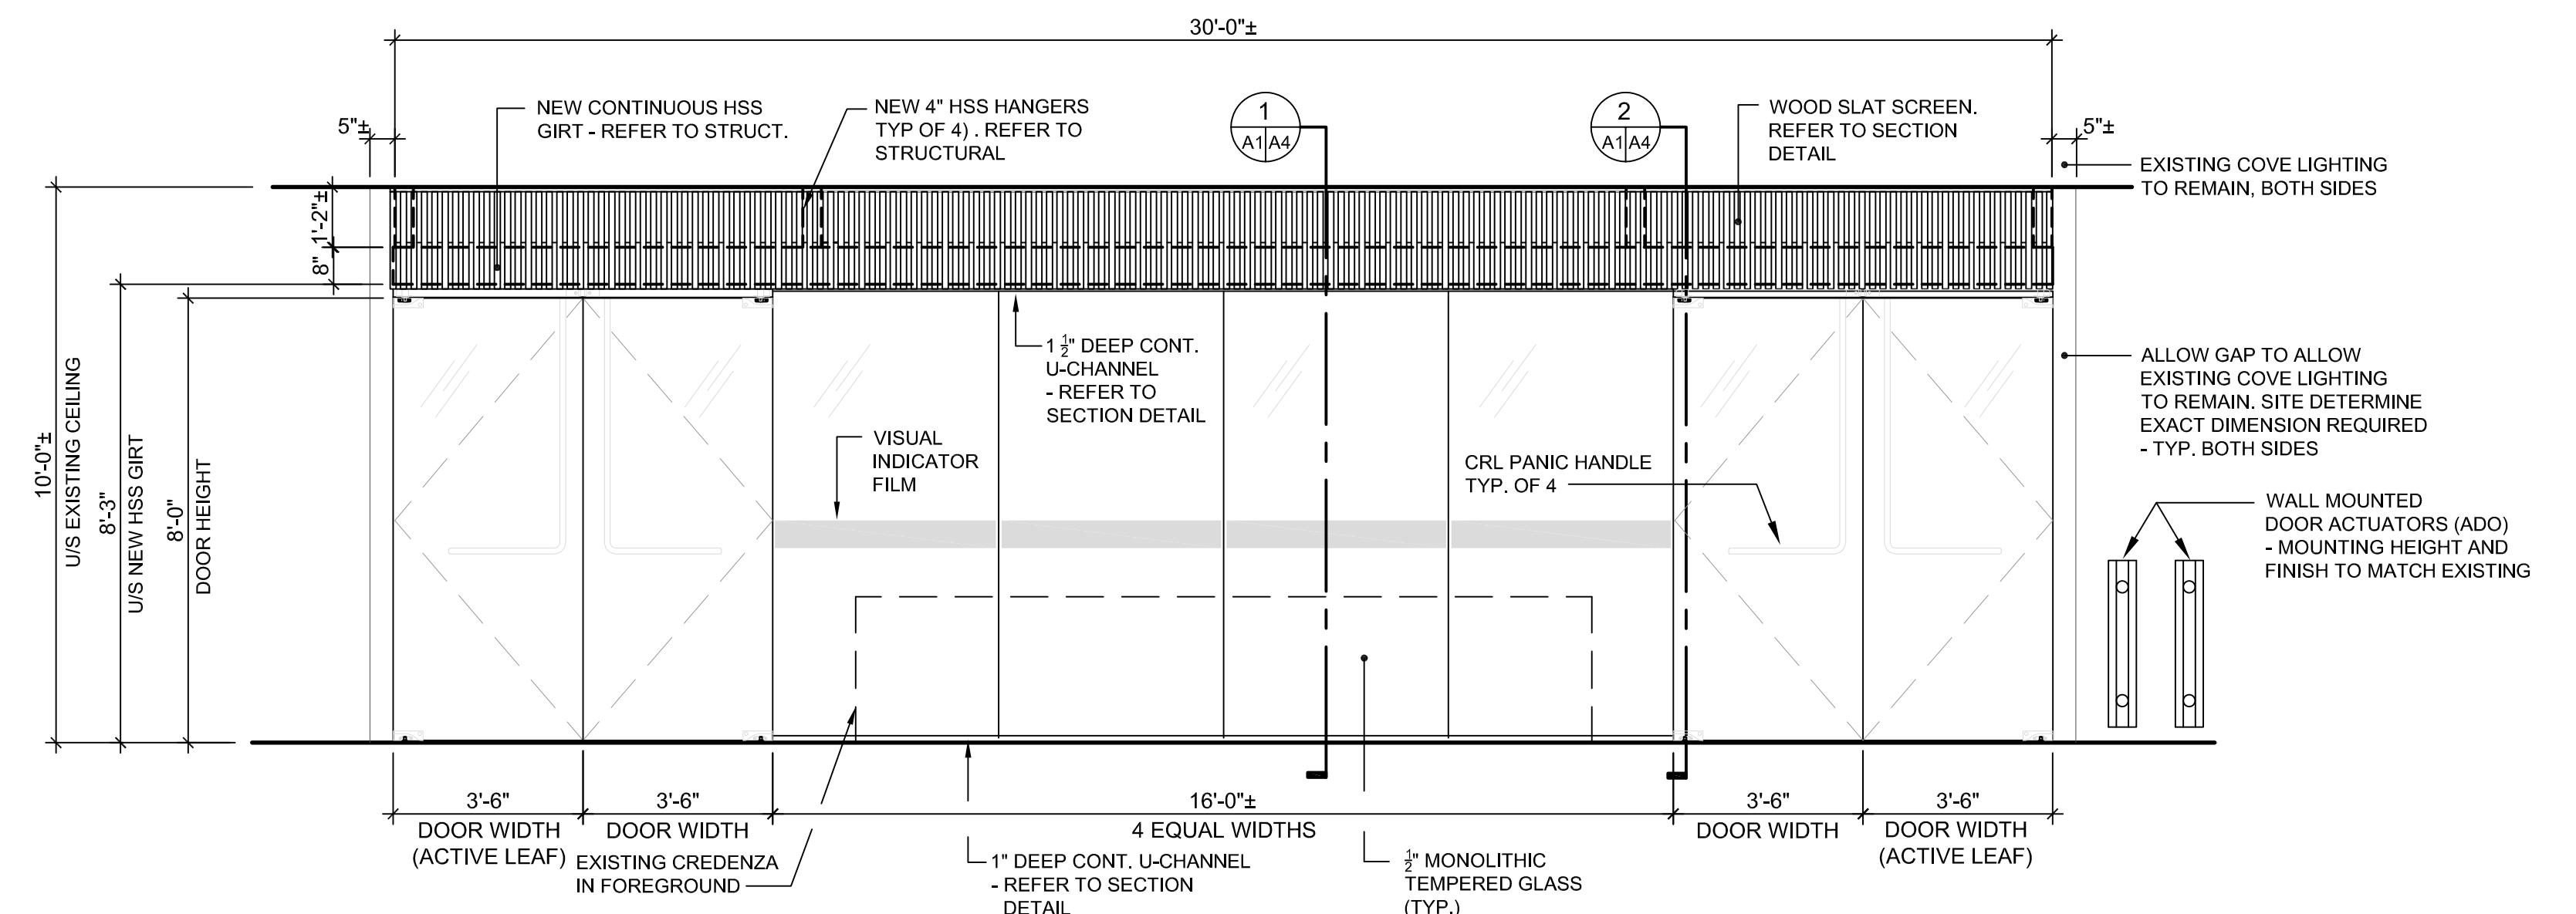

ELEVATION
SCALE: 3/8" = 1'-0"

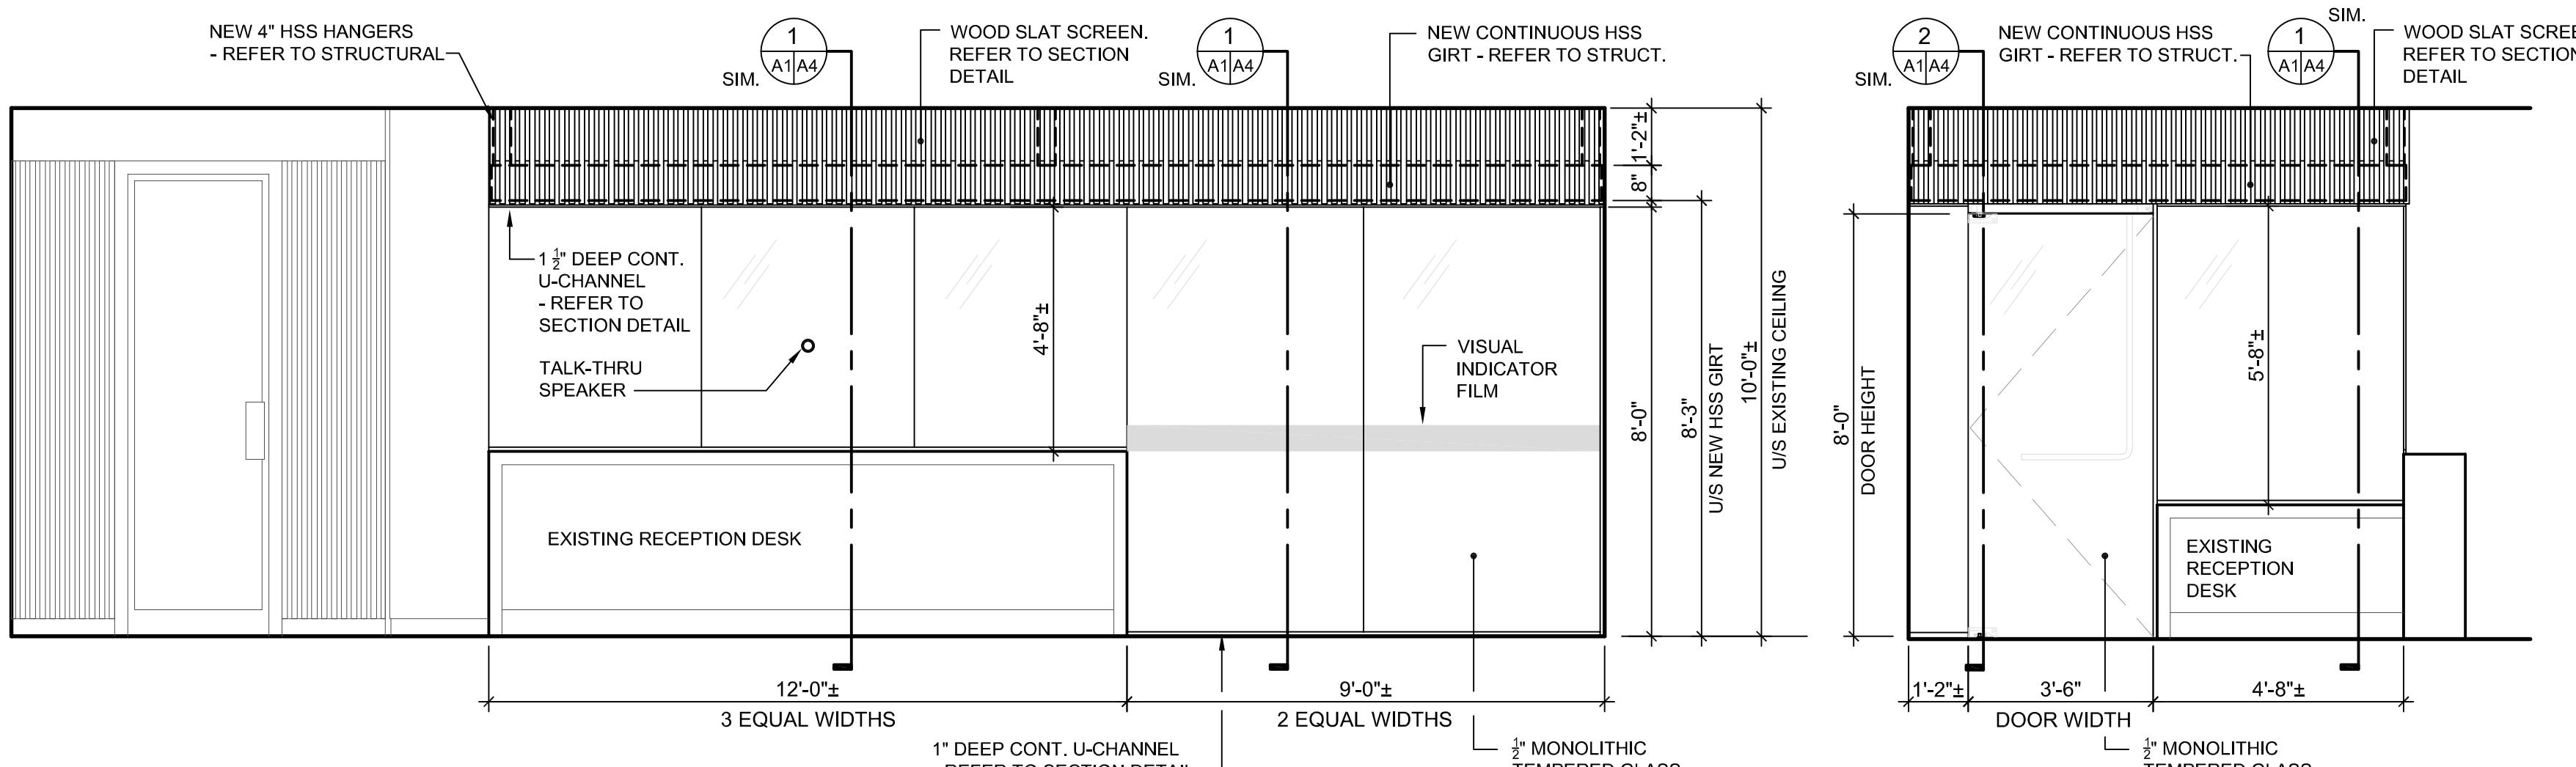

ELEVATION
SCALE: 3/8" = 1'-0"

ASBESTOS

ASBESTOS MAYBE PRESENT BEHIND WALLS, CEILING SPACES & FLOORS. IF ASBESTOS OR ANY HAZARDOUS MATERIAL IS FOUND, STOP WORK IMMEDIATELY AND CONTACT CITY OF WINNIPEG CENTRAL CONTROLS @ 204 986-2351.

▲	REISSUED FOR ADDENDUM No.2	PAS	24.11
1	ISSUED FOR CONSTRUCTION	PAS	04.11
A	ISSUED FOR CLASS 2 ESTIMATE	JWF	19.08
No.	REVISION/DESCRIPTION	BY	DATE

SEAL

ELEVATION
SCALE: 3/8" = 1'-0"

DOOR HARDWARE SCHEDULE

HARDWARE GROUP No.1 FOR USE ON DOOR D01

QTY	DESCRIPTION	CATALOG NUMBER	FINISH	MFR
1 EA	TOP RAIL	BY DOOR SUPPLIER		CRL
1 EA	BOTTOM PIVOT	7255J BTM	613	IVE
1 EA	ROCKWOOD ARCHITECTURAL EXIT DEVICE	PDU8500-3	613	ROC
1 EA	HIGH SECURITY MORTISE CYLINDER	BY OWNER	613	
1 EA	ELECTRIC STRIKE	ESK-SGL (FAIL SECURE)	613	FOL
1 EA	CONC. AUTO OPERATOR	2811 STD/CP POS120V/ 240V AC OR SW2001	ANDKB	LCN
1 EA	SWITCH	8310-806K (ON/OFF / HOLD OPEN)		LCN
2 EA	36" TALL COLUMN PUSH PLATE	CM-75364 BRZ	BRZ	CAM
1 EA	WALL STOP	WS406/407CVX	613	IVE
1 EA	SEAL	BY DOOR AND FRAME SUPPLIER		
1 EA	ADVANCED LOGIC RELAY	CX-33		CAM
1 EA	DOOR CONTACT	BY SECURITY CONTRACTOR		
1 EA	POWER SUPPLY	PS902 BBK KL900 120/240 VAC	LGR	SCE
1 EA	BOTTOM RAIL	BY DOOR SUPPLIER		
1 EA	FOB / CARD / KEYPAD READER	BY SECURITY CONTRACTOR		

NOTE
DOOR NORMALLY CLOSED AND LOCKED.
VALID CREDENTIALS AT READER RELEASE ELECTRIC STRIKE (IN HEADER)
ALLOWING ENTRY VIA PULL AND OR PRESSING ACTUATOR WILL ENGAGE
OPERATOR FOR ASSISTED ENTRY.
FREE EGRESS AT ALL TIMES VIA PUSH BAR AND / OR PRESSING ACTUATOR WILL
RELEASE ELECTRIC STRIKE AND ENGAGE OPERATOR FOR ASSISTED EGRESS.

HARDWARE GROUP No.2 FOR USE ON DOORS D02 & D03

QTY	DESCRIPTION	CATALOG NUMBER	FINISH	MFR
2 EA	TOP RAIL	BY DOOR SUPPLIER		CRL
2 EA	BOTTOM PIVOT	7255J BTM	613	IVE
2 EA	ROCKWOOD ARCHITECTURAL EXIT DEVICE	PDU8500-3	613	ROC
1 EA	HIGH SECURITY MORTISE CYLINDER	BY OWNER	613	
1 EA	ELECTRIC STRIKE	ESK-DBL (FAIL SECURE)	613	FOL
1 EA	CONCEALED CLOSER	2015 WMS	695	LCN
1 EA	CONC. AUTO OPERATOR	2811 STD/CP POS120V/ 240V AC OR SW2001	ANDKB	LCN
2 EA	36" TALL COLUMN PUSH PLATE	CM-75364 BRZ	BRZ	CAM
1 EA	SEAL	BY DOOR AND FRAME SUPPLIER		
1 EA	ADVANCED LOGIC RELAY	CX-33		CAM
2 EA	DOOR CONTACT	BY SECURITY CONTRACTOR		
1 EA	POWER SUPPLY	PS902 BBK KL900 120/240 VAC	LGR	SCE
2 EA	BOTTOM RAIL	BY DOOR SUPPLIER		
1 EA	FOB / CARD / KEYPAD READER	BY SECURITY CONTRACTOR		

NOTE
DOOR NORMALLY CLOSED AND LOCKED.
VALID CREDENTIALS AT READER RELEASE ELECTRIC STRIKE (IN HEADER)
ALLOWING ENTRY VIA PULL AND OR PRESSING ACTUATOR WILL ENGAGE
OPERATOR FOR ASSISTED ENTRY.
FREE EGRESS AT ALL TIMES VIA PUSH BAR AND / OR PRESSING ACTUATOR WILL
RELEASE ELECTRIC STRIKE AND ENGAGE OPERATOR FOR ASSISTED EGRESS.

HARDWARE GROUP No.3 FOR USE ON DOORS D04

QTY	DESCRIPTION	CATALOG NUMBER	FINISH	MFR
1 EA	TOP RAIL	BY DOOR SUPPLIER		CRL
1 EA	BOTTOM PIVOT	7255J BTM	613	IVE
1 EA	ROCKWOOD ARCHITECTURAL EXIT DEVICE	PDU8500-3	613	ROC
1 EA	HIGH SECURITY MORTISE CYLINDER	BY OWNER	613	
1 EA	ELECTRIC STRIKE	ESK-SGL (FAIL SECURE)	613	FOL
1 EA	CONCEALED CLOSER	2015 WMS	695	LCN
1 EA	WALL STOP	WS406/407CVX	613	IVE
1 EA	SEAL	BY DOOR AND FRAME SUPPLIER		
1 EA	DOOR CONTACT	BY SECURITY CONTRACTOR		
1 EA	POWER SUPPLY	PS902 BBK KL900 120/240 VAC	LGR	SCE
1 EA	BOTTOM RAIL	BY DOOR SUPPLIER		
1 EA	FOB / CARD / KEYPAD READER	BY SECURITY CONTRACTOR		

NOTE
DOOR NORMALLY CLOSED AND LOCKED.
VALID CREDENTIALS AT READER RELEASE ELECTRIC STRIKE (IN HEADER)
ALLOWING ENTRY VIA PULL AND OR PRESSING ACTUATOR WILL ENGAGE
OPERATOR FOR ASSISTED ENTRY.
FREE EGRESS AT ALL TIMES VIA PUSH BAR AND / OR PRESSING ACTUATOR WILL
RELEASE ELECTRIC STRIKE AND ENGAGE OPERATOR FOR ASSISTED EGRESS.

DATE 2025.06.27 DESIGN BY JWF / PAS DRAWN BY PAS CHECKED BY APPROVED BY



THE CITY OF WINNIPEG
ASSETS & PROJECT MANAGEMENT DEPARTMENT
MUNICIPAL ACCOMMODATIONS DIVISION
3-65 GARRY STREET, R3C 4K4

PROJECT
CITY HALL - COUNCIL BUILDING
RECEPTION SECURITY WALLS

510 MAIN STREET

SHEET TITLE
INTERIOR ELEVATIONS
DOOR HARDWARE SCHEDULE

SCALE AS SHOWN PROJECT No: 2025-100 SHEET No: A3R1